
### NEVADA TAHOE CONSERVATION DISTRICT

# ZEPHYR COVE WATER QUALITY IMPROVEMENT PROJECT


## PHASE 1

IN THE COUNTY OF DOUGLAS EIP # 01.01.01.15

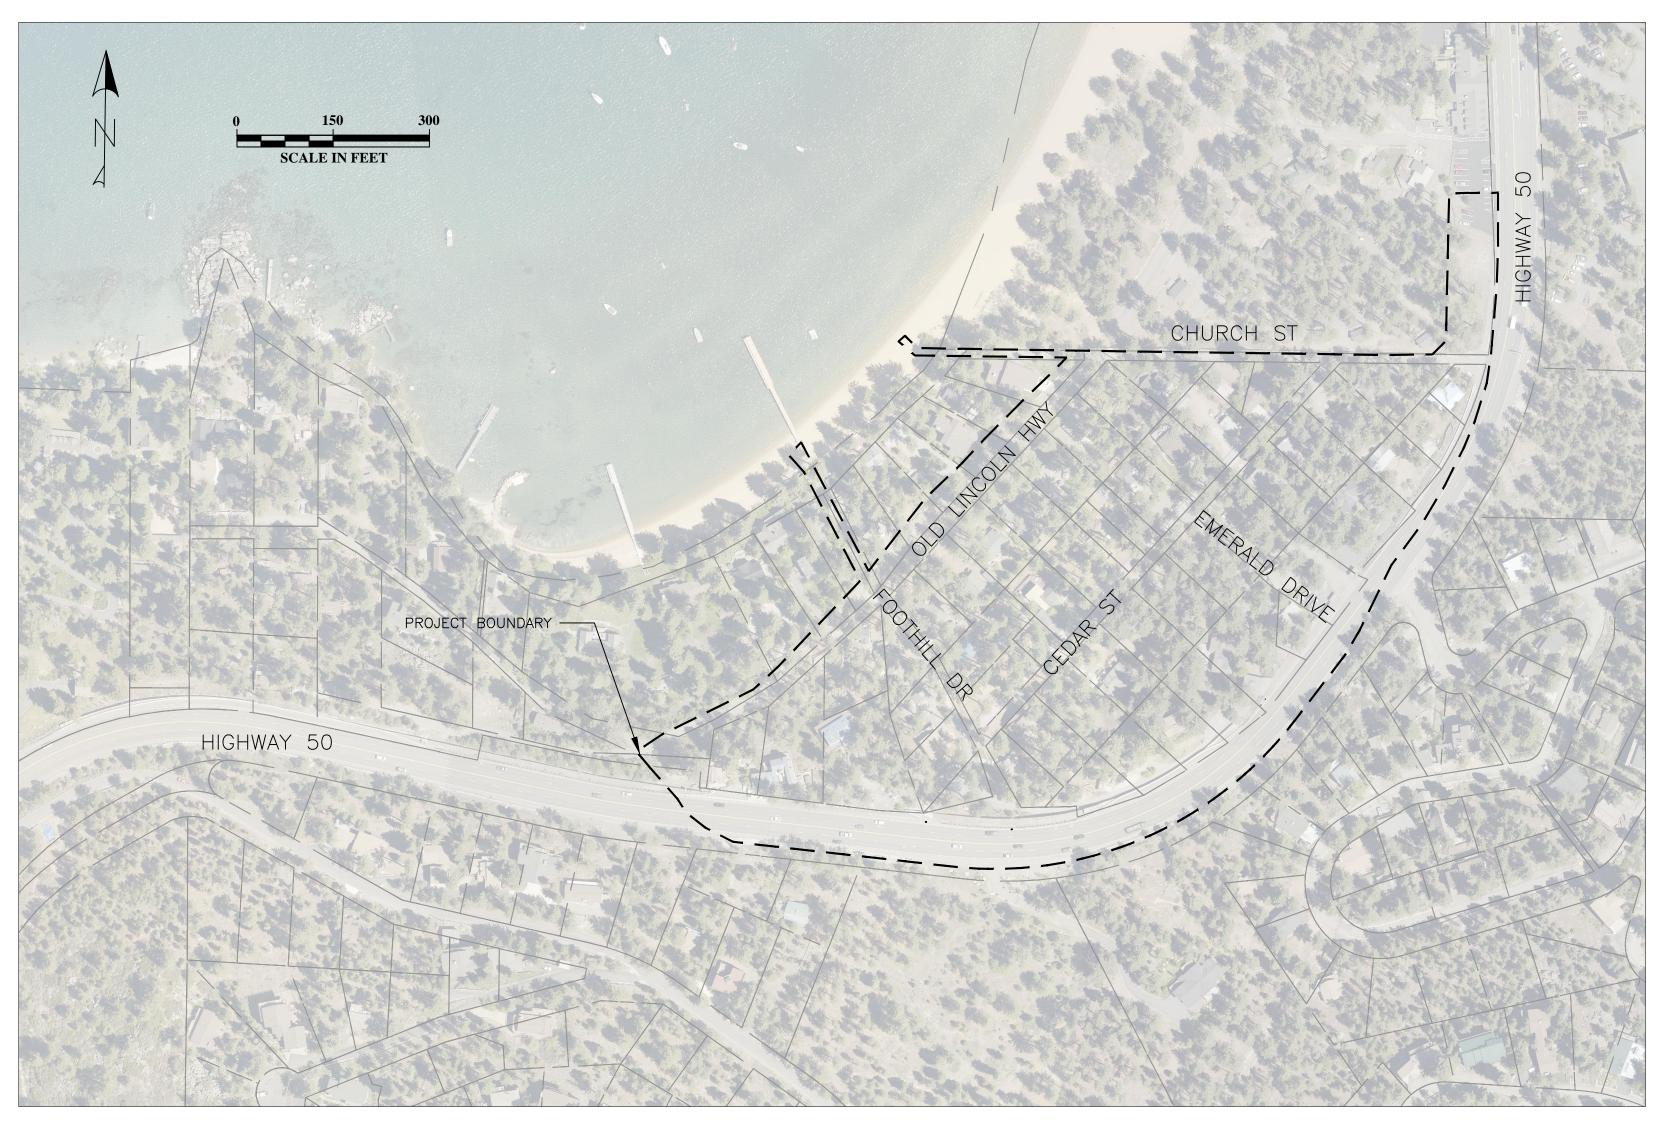

PLAN

SCALE: 1" = 150'

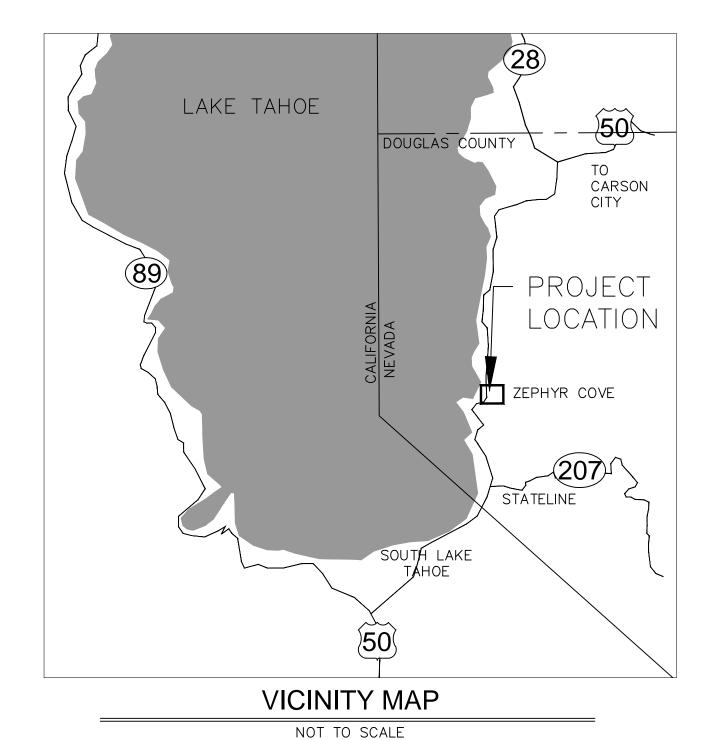








### SHEET INDEX

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OVERVIEW, STAGING, STORAGE_	C-1
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#### ENGINEER:

(775) 586-1610



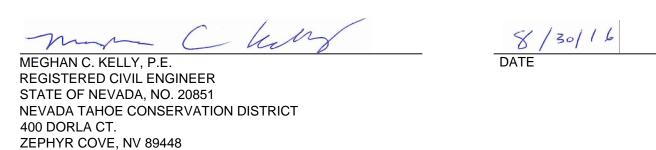

Conservation of the state of th

ZEPHYR COVE WATER QUALITIMPROVEMENT PROJECT - PHAS

BAR IS ONE INCH ON ORIGINAL DRAWING, ADJUST SCALES FOR REDUCED PLOTS

0"

DESIGNED/DRAWN
MCK/MCK
CHECKED
MBG
DATE
8/2016
SCALE

AS SHOWN
PROJECT

ZC WQIP

SHEET

*i* 1 of 7 2. CONTRACTOR SHALL MAINTAIN A SET OF PLANS ON SITE SHOWING "AS CONSTRUCTED" CHANGES. UPON COMPLETION, CONTRACTOR SHALL SUPPLY NDOT, DOUGLAS COUNTY, AND NTCD A SET OF "AS BUILT" PLANS. SEE SPECIAL PROVISIONS.

3. MOBILIZATION/STAGING AND STORAGE AREAS ARE TO BE SECURED BY THE CONTRACTOR AND APPROVED BY TRPA. THE CONTRACTOR SHALL BE RESPONSIBLE FOR MAINTENANCE OF MOBILIZATION SITES, INCLUDING PLACEMENT AND MAINTENANCE OF BMPS.

4. PRIOR TO STARTING WORK, THE CONTRACTOR SHALL INSTALL TEMPORARY BMP MEASURES AT LOCATIONS WHERE NEEDED TO CONTROL EROSION AND WATER POLLUTION DURING THE CONSTRUCTION OF THE PROJECT. THE BMP MEASURES SHALL REMAIN IN PLACE AND SHALL BE MAINTAINED IN A FUNCTIONAL CONDITION FOR THE DURATION OF THE CONSTRUCTION. DURING CONSTRUCTION ENVIRONMENTAL PROTECTION DEVICES, SUCH AS EROSION CONTROL, DUST CONTROL, AND VEGETATION PROTECTION DEVICES SHALL BE MAINTAINED AT ALL TIMES. SILT FENCE IS REQUIRED AT ALL CROSS DRAIN OUTLETS. SILT FENCE OR SEDIMENT LOGS WILL BE REQUIRED AT OTHER LOCATIONS AS SHOWN ON THE DRAWINGS OR STAKED IN THE FIELD BY THE ENGINEER. ALL EROSION CONTROL MEASURES SHALL MEET OR EXCEED TRPA REQUIREMENTS.

5. ALL EXISTING VEGETATION SHALL BE PRESERVED UNLESS SPECIFICALLY IDENTIFIED BY THE ENGINEER FOR REMOVAL. BMP'S TO PROTECT VEGETATION SHALL BE INSTALLED BY THE CONTRACTOR IF REQUIRED BY TRPA. CONTRACTOR TO REVEGETATE ANY AREAS OUTSIDE THE DISTURBED AREA SHOWN ON THE PLANS WITH PLANTS APPROVED BY TRPA AT THEIR OWN EXPENSE.

6. NTCD WILL PROVIDE ONE SET OF CONSTRUCTION STAKES AT NTCD'S EXPENSE. ADDITIONAL CONSTRUCTION STAKES WILL BE PROVIDED AT THE CONTRACTOR'S EXPENSE. LIMITS FOR ALL ITEMS OF WORK SHALL BE STAKED IN THE FIELD BY THE ENGINEER. THESE LIMITS AND THE RESULTING TREATMENT LENGTH/AREAS MAY VARY FROM THOSE SHOWN ON THE DRAWINGS. PAYMENT FOR ITEMS OF WORK WILL BE MADE FOR THE AMOUNT AUTHORIZED BY THESE FIELD STAKED LIMITS AND THE SPECIAL TECHNICAL PROVISIONS.

7. UTILITY LOCATIONS SHOWN ON THE DRAWINGS ARE APPROXIMATE. WHERE EXCAVATION IS NECESSARY, THE CONTRACTOR SHALL CONTACT UNDERGROUND SERVICE ALERT (USA) AND ALL AFFECTED UTILITY COMPANIES TO LOCATE ALL BURIED UTILITIES AT LEAST 48 HOURS PRIOR TO EXCAVATION. THE CONTRACTOR SHALL COORDINATE WITH UTILITY COMPANIES FOR RELOCATION OF UTILITIES AS REQUIRED BY THE WORK. WHENEVER CONNECTIONS TO OR CLEARANCE FROM ANY UTILITY IS REQUIRED, THE CONTRACTOR SHALL POTHOLE TO VERIFY THE LOCATION, SIZE AND MATERIAL OF THE UTILITY PRIOR TO CONSTRUCTION.

ASPHALT REPLACEMENT SHALL INCORPORATE A 4%  $\pm 1\%$  CROSS SLOPE BETWEEN THE SAWCUT AND THE NEW ROADSIDE TREATMENT. NEW ROADSIDE FLOW CONVEYANCES SHALL INCORPORATE SUCH GRADE AS NECESSARY TO GUARANTEE WATER CONTINUES TO FLOW IN THE PRESENT DIRECTION, WITHOUT PONDING OR BREAKOUTS.

). ANY DAMAGE DONE BY THE CONTRACTOR OR HIS SUBCONTRACTORS TO PRIVATE PROPERTY AND/OR OUTSIDE OF THE NOTED LIMITS OF WORK IS SOLELY THE RESPONSIBILITY OF THE CONTRACTOR AND/OR HIS SUBCONTRACTORS.

10. NTCD WILL PROVIDE INITIAL TESTING AND INSPECTION OF WORK AND MATERIAL AT NTCD'S EXPENSE. THE COST OF REMOVAL AND/OR REPLACEMENT OF ANY DEFECTIVE WORK OR MATERIAL IS THE RESPONSIBILITY OF THE CONTRACTOR. THE COST OF RETESTING AND/OR INSPECTING OF REPLACED WORK AND MATERIAL IS ALSO THE RESPONSIBILITY OF THE CONTRACTOR. SUCH COSTS WILL BE DEDUCTED FROM ANY MONEYS DUE OR WHICH MAY BECOME DUE TO THE CONTRACTOR.

11. STANDARD WORK DAYS SHALL BE MONDAY THROUGH FRIDAY. SATURDAY MAY BE WORKED ON OCCASION ONLY TO MAKE UP FOR WEATHER DELAYS OR OTHER SCHEDULE DELAYS WITH ENGINEER APPROVAL. NOISE GENERATING ACTIVITIES WILL BE LIMITED TO THE HOURS OF 8:00 AM TO 6:30 PM.

12. NOISE SHALL BE REDUCED BY THE MANDATORY USE OF MUFFLERS ON ALL CONSTRUCTION VEHICLES AND EQUIPMENT. WHERE FEASIBLE, SOLENOIDAL PAVEMENT BREAKERS WILL BE USED IN LIEU OF AIR POWERED JACK HAMMERS. NOISE GENERATING ACTIVITIES WILL BE LIMITED TO THE HOURS OF 8:00 AM TO 6:30 PM.

13. THE CONTRACTOR SHALL PROVIDE A WATER TRUCK TO WATER AREAS AS NECESSARY TO CONTROL DUST. THE CONTRACTOR WILL PROVIDE SWEEPING PER SPECIFICATION.

14. ALL TREES AND NATURAL VEGETATION TO REMAIN ON THE SITE SHALL BE PROTECTED PER TRPA.

15. SOIL AND CONSTRUCTION MATERIAL SHALL NOT BE TRACKED OFF THE CONSTRUCTION SITE. GRADING OPERATIONS SHALL CEASE IN THE EVENT THAT A DANGER OF VIOLATING THIS CONDITION EXISTS.

16. LOOSE SOIL MOUNDS OR SURFACES SHALL BE PROTECTED FROM WIND OR WATER EROSION BY BEING APPROPRIATELY COVERED WHEN CONSTRUCTION IS NOT IN ACTIVE PROGRESS OR WHEN REQUIRED BY TRPA.

17. EXCAVATED MATERIAL SHALL BE STORED UPGRADE FROM THE EXCAVATED AREA WHENEVER POSSIBLE. NO MATERIAL SHALL BE STORED IN ANY STREAM ENVIRONMENT ZONE (SEZ) OR WET AREA.

18. ONLY EQUIPMENT OF A SIZE AND TYPE THAT WILL DO THE LEAST AMOUNT OF DAMAGE, UNDER PREVAILING SITE CONDITIONS, AND CONSIDERING THE NATURE OF THE WORK TO BE PERFORMED, WILL BE USED.

19. NO WASHING OF VEHICLES OR HEAVY EQUIPMENT, INCLUDING CEMENT MIXERS, SHALL BE PERMITTED ANYWHERE ON THE SUBJECT PROPERTY UNLESS AUTHORIZED BY TRPA IN WRITING.

20. NO VEHICLE OR HEAVY EQUIPMENT SHALL BE ALLOWED IN A STREAM ENVIRONMENT ZONE OR WET AREA EXCEPT AS AUTHORIZED BY TRPA.

21. ALL CONSTRUCTION SHALL BE WINTERIZED BY OCTOBER 15 TO REDUCE THE WATER QUALITY IMPACTS ASSOCIATED WITH WINTER WEATHER.

22. THE CONTRACTOR AND/OR THEIR AUTHORIZED AGENTS SHALL EACH DAY REMOVE ALL SEDIMENT, MUD, CONSTRUCTION DEBRIS, OR OTHER POTENTIAL POLLUTANTS THAT MAY HAVE BEEN DISCHARGED TO, OR ACCUMULATE IN, THE NDOT RIGHT-OF-WAYS AS A RESULT OF CONSTRUCTION ACTIVITIES ASSOCIATED WITH THIS SITE DEVELOPMENT OR CONSTRUCTION PROJECT. SUCH MATERIALS SHALL BE PREVENTED FROM ENTERING THE STORM SYSTEM.

23. ADDITIONAL CONSTRUCTION SITE DISCHARGE BEST MANAGEMENT PRACTICES MAY BE REQUIRED OF THE OWNER AND HIS OR HER AGENTS DUE TO UNFORESEEN EROSION PROBLEMS OR IF THE SUBMITTED PLAN DOES NOT MEET THE PERFORMANCE STANDARDS SPECIFIED IN THE TRUCKEE MEADOWS CONSTRUCTION SITE BEST MANAGEMENT PRACTICE HANDBOOK.

24. TEMPORARY OR PERMANENT STABILIZATION PRACTICES WILL BE INSTALLED ON DISTURBED AREAS AS SOON AS PRACTICABLE AND NO LONGER THAN 24 HOURS AFTER THE CONSTRUCTION ACTIVITY IN THAT PORTION OF THE SITE HAS BEEN TEMPORARILY OR PERMANENTLY CEASED.

25. AT A MINIMUM, THE CONTRACTOR OR HIS AGENT SHALL INSPECT ALL DISTURBED AREAS, AREAS USED FOR STORAGE OF MATERIALS AND EQUIPMENT THAT ARE EXPOSED TO PRECIPITATION, VEHICLE ENTRANCE AND EXIT LOCATIONS, AND ALL BMP'S WEEKLY, PRIOR TO A FORECASTED RAIN EVENT AND WITHIN 24 HOURS AFTER ANY ACTUAL RAIN EVENT. SOME EXCEPTIONS TO WEEKLY INSPECTIONS MAY APPLY, SUCH AS FROZEN GROUND CONDITIONS OF SUSPENSION OF LAND DISTURBANCE ACTIVITIES.

26. TRAFFIC CONTROL AND LANE CLOSURES WILL BE PER NDOT STANDARD SPECIFICATIONS.


27. ACCESS TO HOMES AND BUSINESSES SHALL BE MAINTAINED THROUGHOUT THE DURATION OF CONSTRUCTION

#### **ABBREVIATIONS**

	ADDITEVIATION	<u> </u>	
NOT ALL ABI	BREVIATIONS LISTED ARE USED IN THESE PLANS		
4.B.	AGGREGATE BASE	MDD	MAXIMUM DRY DENSITY
AC.	ACRE	MJ	MECHANICAL JOINT
AC OR A.C.	ASPHALT CONCRETE OR ASBESTOS CEMENT	MI.	MILE
	ADDROVIMATE	MIN. MISC.	MINIMUM
NPPROX. NG.	APPROXIMATE AVERAGE	N	MISCELLANEOUS NORTH
WWA	AMERICAN WATER WORKS ASSOCIATION	NAC	NEVADA ADMINISTRATIVE CODE
BC	BEGIN CURVE	N.I.C.	NOT IN CONTRACT
GN	BEGIN	NDOT	NEVADA DEPT OF TRANSPORTATION
&G	CURB AND GUTTER	NTCD	NEVADA TAHOE CONSERVATION DISTRICT
ATV	CABLE TELEVISION	N.T.S.	NOT TO SCALE
.B. BM	CATCH BASIN	NO. OC	NUMBER ON CENTER
L L	CHANNEL BED MATERIAL CENTERLINE	OD	ON CENTER OUTSIDE DIAMETER
- _F	CONSTRUCTION LIMIT FENCE	OFF	OFFSET
-' _R.	CLEAR	OG	ORIGINAL GRADE
D.	CLEAN OUT	OH(E/T)	OVERHEAD ELECTRIC OR TELEPHONE LINES
DNST.	CONSTRUCT	±	PLUS OR MINUS
F	CUBIC FEET	PT.	POINT
MP	CORRIGATED METAL PIPE	PCC	POINT OF COMPOUND CURVE, PORTLAND CEMEN
MAP	CORRIGATED METAL ARCH PIPE	PC PI	POINT OF CURVATURE
/ 0Ц	CUBIC YARD	PI PIP	POINT OF INFLECTION
BH EG	DIAMETER AT BREAST HEIGHT DEGREE(S)	PVC	PROTECT IN PLACE POLYVINYL CHLORIDE
G 3.	DECOMPOSED GRANITE	PVMT	PAVEMENT
<i>3</i> .	DROP INLET	POC	POINT ON CURVE
٨.	DIAMETER	POS	POSITIVE
	DIMENSION RATIO	PRC	POINT OF REVERSE CURVE
/G	DRAWING	PSI	POUNDS PER SQUARE INCH
/, DWY	DRIVEWAY	PL	PROPERTY LINE
<b>5</b> -	EACH	PO	PUSH ON
SE.	EASEMENT	PUE	PUBLIC UTILITY EASEMENT
EC	EXISTING GRADE ELECTRIC	R RCP	RADIUS REINFORCED CONCRETE PIPE
)	EDGE OF PAVEMENT	REVEG	REVEGATATION
	ELEVATION	RLC	ROCK LINED CHANNEL
,	END CURVE	RT,R	RIGHT
<b>(.</b>	EXISTING	R/W, ROW	
	FINISH GRADE	S	SLOPE OR SOUTH
<b> </b>   <b>A</b>	FIRE HYDRANT	SD	STORM DRAIN
	FLANGE COUPLER ADAPTER	SDMH	STORM DRAIN MANHOLE
S	FLARED END SECTION (METAL) FILTER FENCE	SDR	STANDARD DIMENSION RATIO
	FLOWLINE	SF	SQUARE FOOT/FEET
G	FLANGED	SHT STA	SHEET
	FOOT, FEET	STD	STATION STANDARD
3	FOOTING	SS	
	FLUSH VALVE	SSCO.	
	DEGREE	SSMH	SANITARY SEWER MANHOLE
	GAS GATE VALVE	SSPWC	
	GRADE BREAK	SWPPP	
PE	HIGH DENSITY POLYETHYLENE	SY	SQUARE YARD
	NON-PERFORATED HIGH DENSITY POLYETHYLENE	TBC	TOP BACK OF CURB
PE-P	PERFORATED HIGH DENSITY POLYETHYLENE	TOC TRPA	TOP OF CURB
	HIGH POINT	TW	TAHOE REGIONAL PLANNING AGENCY TOP OF WALL
	HORIZONTAL	(TYP)	TYPICAL
Υ	HIGHWAY	UGE	UNDERGROUND ELECTRIC LINES
	INCH	UGT	UNDERGROUND TELEPHONE LINES
0	INVERT ELEVATION	VC	VERTICAL CURVE
R. GID	IRRIGATION INCLINE VILLAGE GENERAL IMPROVEMENT DISTRICT	VG	VALLEY GUTTER
סופ	LEFT	VPC	VERTICAL POINT OF CURVATURE
N.	LENGTH	VPI	VERTICAL POINT OF INFLECTION
11.	LINEAR FEET	VPT W	VERTICAL POINT OF TANGENT
)	LOW IMPACT DEVELOPMENT	W	WATER
	LOW POINT	WL W	WATERLINE WEST
	LUMP SUM	W/	WITH
Η,,,	MANHOLE	WM	WATER METER
4Χ.	MAXIMUM	₹ 1 ¥ I	


#### **LEGEND**

NOTE: LEGENDS PROVIDED ON INDIVIDUAL PLAN SHEETS OVERRIDE THIS LEGEND **EXISTING** PROPOSED —— MAJOR CONTOUR MAJOR CONTOUR MINOR CONTOUR MINOR CONTOUR EXISTING MAJOR CONTOUR LABEL PROPOSED MAJOR CONTOUR LABEL EXISTING ALIGNMENT PROPOSED ALIGNMENT — — EXISTING GRADE (SECTION VIEW) ---- GRADING DAYLIGHT LINE/GRADING LIMIT PROPERTY LINE GRADING LINE/FEATURE LINE PROPOSED GRADE (SECTION VIEW) PAVEMENT — CLF — CONSTRUCTION LIMIT FENCE - SD - STORM DRAIN LINE FILTER FENCE SEDIMENT ROLL CATCH BASIN EROSION CONTROL BLANKET STORM DRAIN MANHOLE  $\otimes$ STAGING AREA WATER LINE WATER METER/ VALVE PROPOSED PIPE PROPOSED CONCRETE/CURB SANITARY SEWER LINE SANITARY SEWER MANHOLE PROPOSED VEGETATION ROCK LINED CHANNEL (PLAN VIEW) OVERHEAD ELECTRIC LINE XERIPAVE PAVERS POWER POLE — UG ☐ UNDER GROUND TELEPHONE LINES ROCK DISSIPATER — OH ← OVERHEAD TELEPHONE LINES — UG FO— UNDERGROUND FIBER OPTIC LINES PROJECT BOUNDARY — GAS — UNDERGROUND GAS LINES PROPOSED FENCE (TYPE SPECIFIED ON

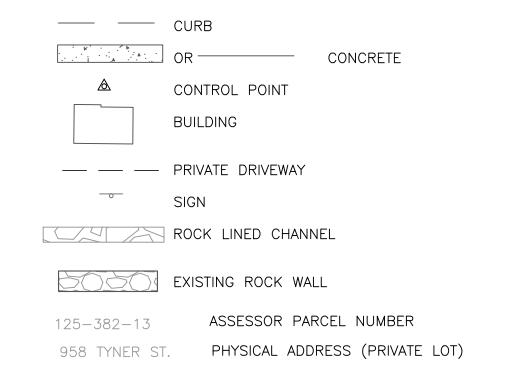

TREE

FIRE HYDRANT

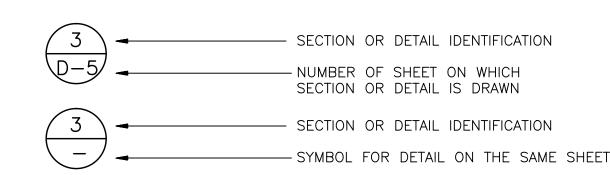

#### HORIZONTAL AND VERTICAL PROJECTION

VERTICAL CONTROL IS DATUM NGVD 29 US FEET; HORIZONTAL CONTROL IS STATE PLANE COORDINATE SYSTEM NEVADA ZONE WEST (U.S. FEET) HARN

#### UTILITIES

CABLE TELEVISION NATURAL GAS ELECTRIC STORM DRAIN SEWER WATER PHONE

USA DIGS

CHARTER COMMUNICATIONS, (775) 588-1077 SOUTHWEST GAS, (877) 860-6022 NV ENERGY, (775) 834-4444 ZEPHYR COVE GID AND NDOT TAHOE DOUGLAS DISTRICT (775)588-5641 DOUGLAS COUNTY (775) 782-9989 FRONTIER (775) 782-0966 (800) 642-2444 OR 811



## MEGHAN C. **KELLY** Exp: 6/30/2017

## < Д ME >IO ZEI MPF

BAR IS ONE INCH ON ORIGINAL DRAWING, ADJUST SCALES FOR REDUCED PLOTS

0"

DESIGNED/DRAWN MCK/MCK CHECKED MBG


DATE 8/2016 SCALE


AS SHOWN **PROJECT** 

ZC WQIP


SHEET


2 of 7

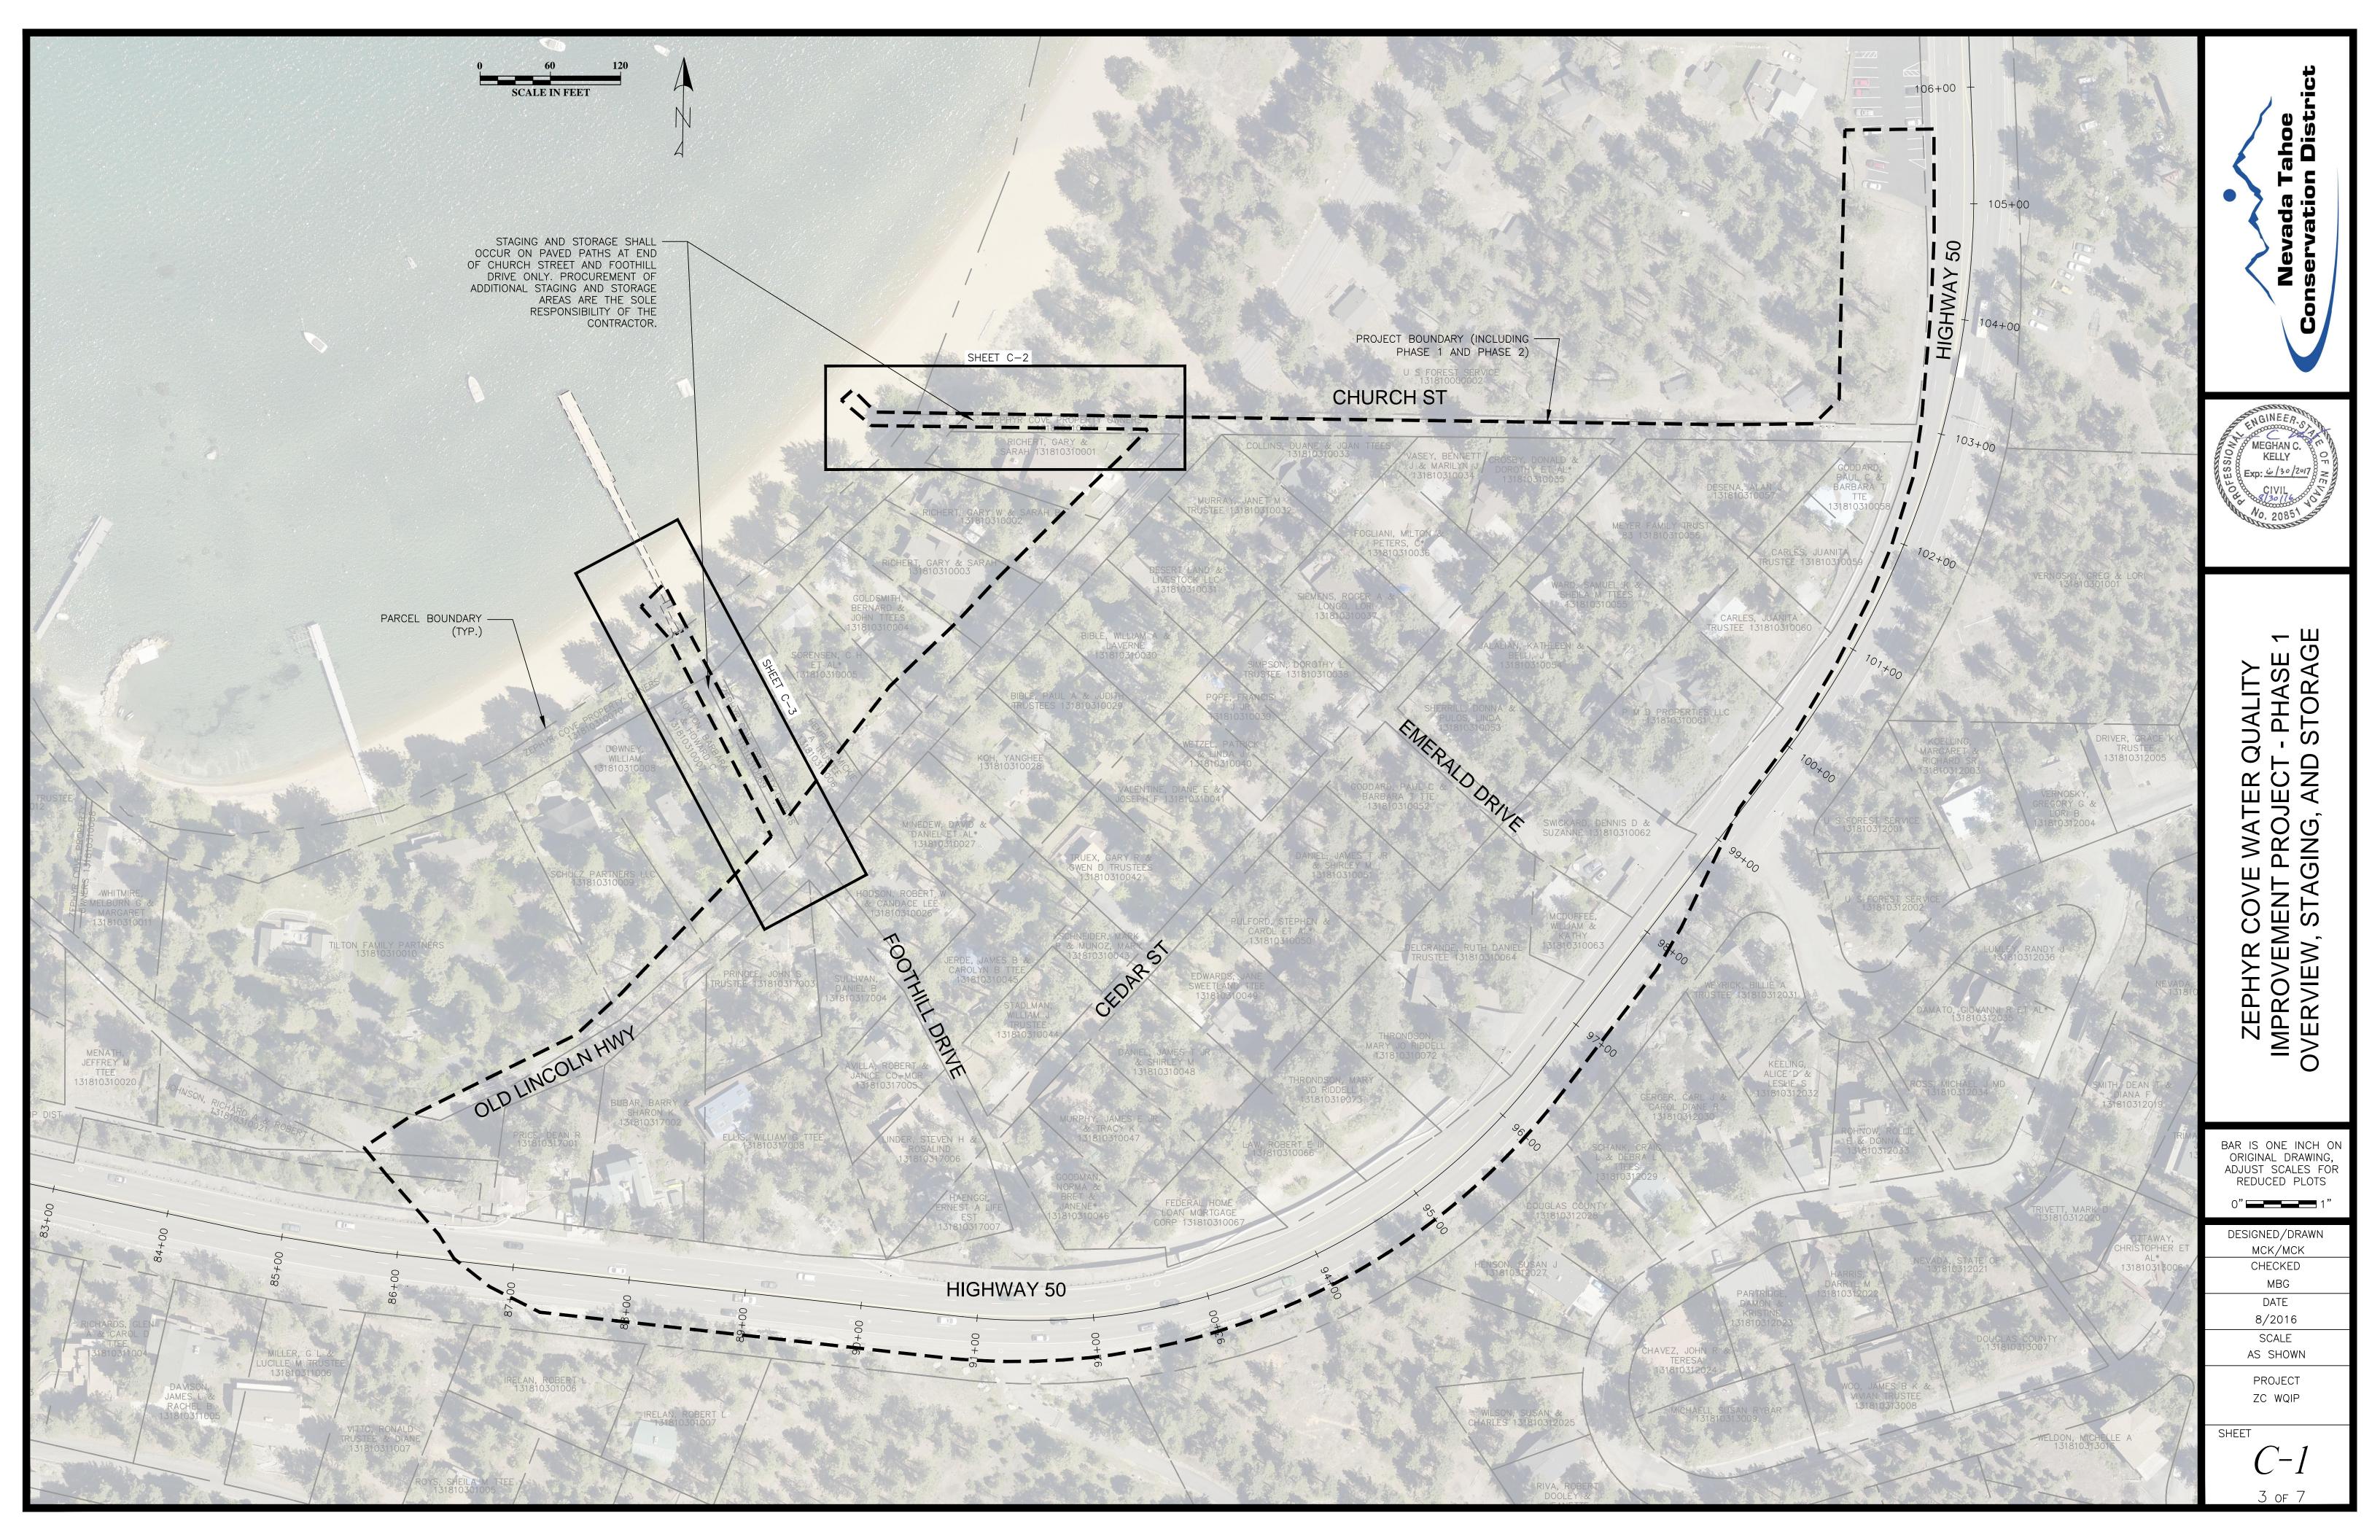


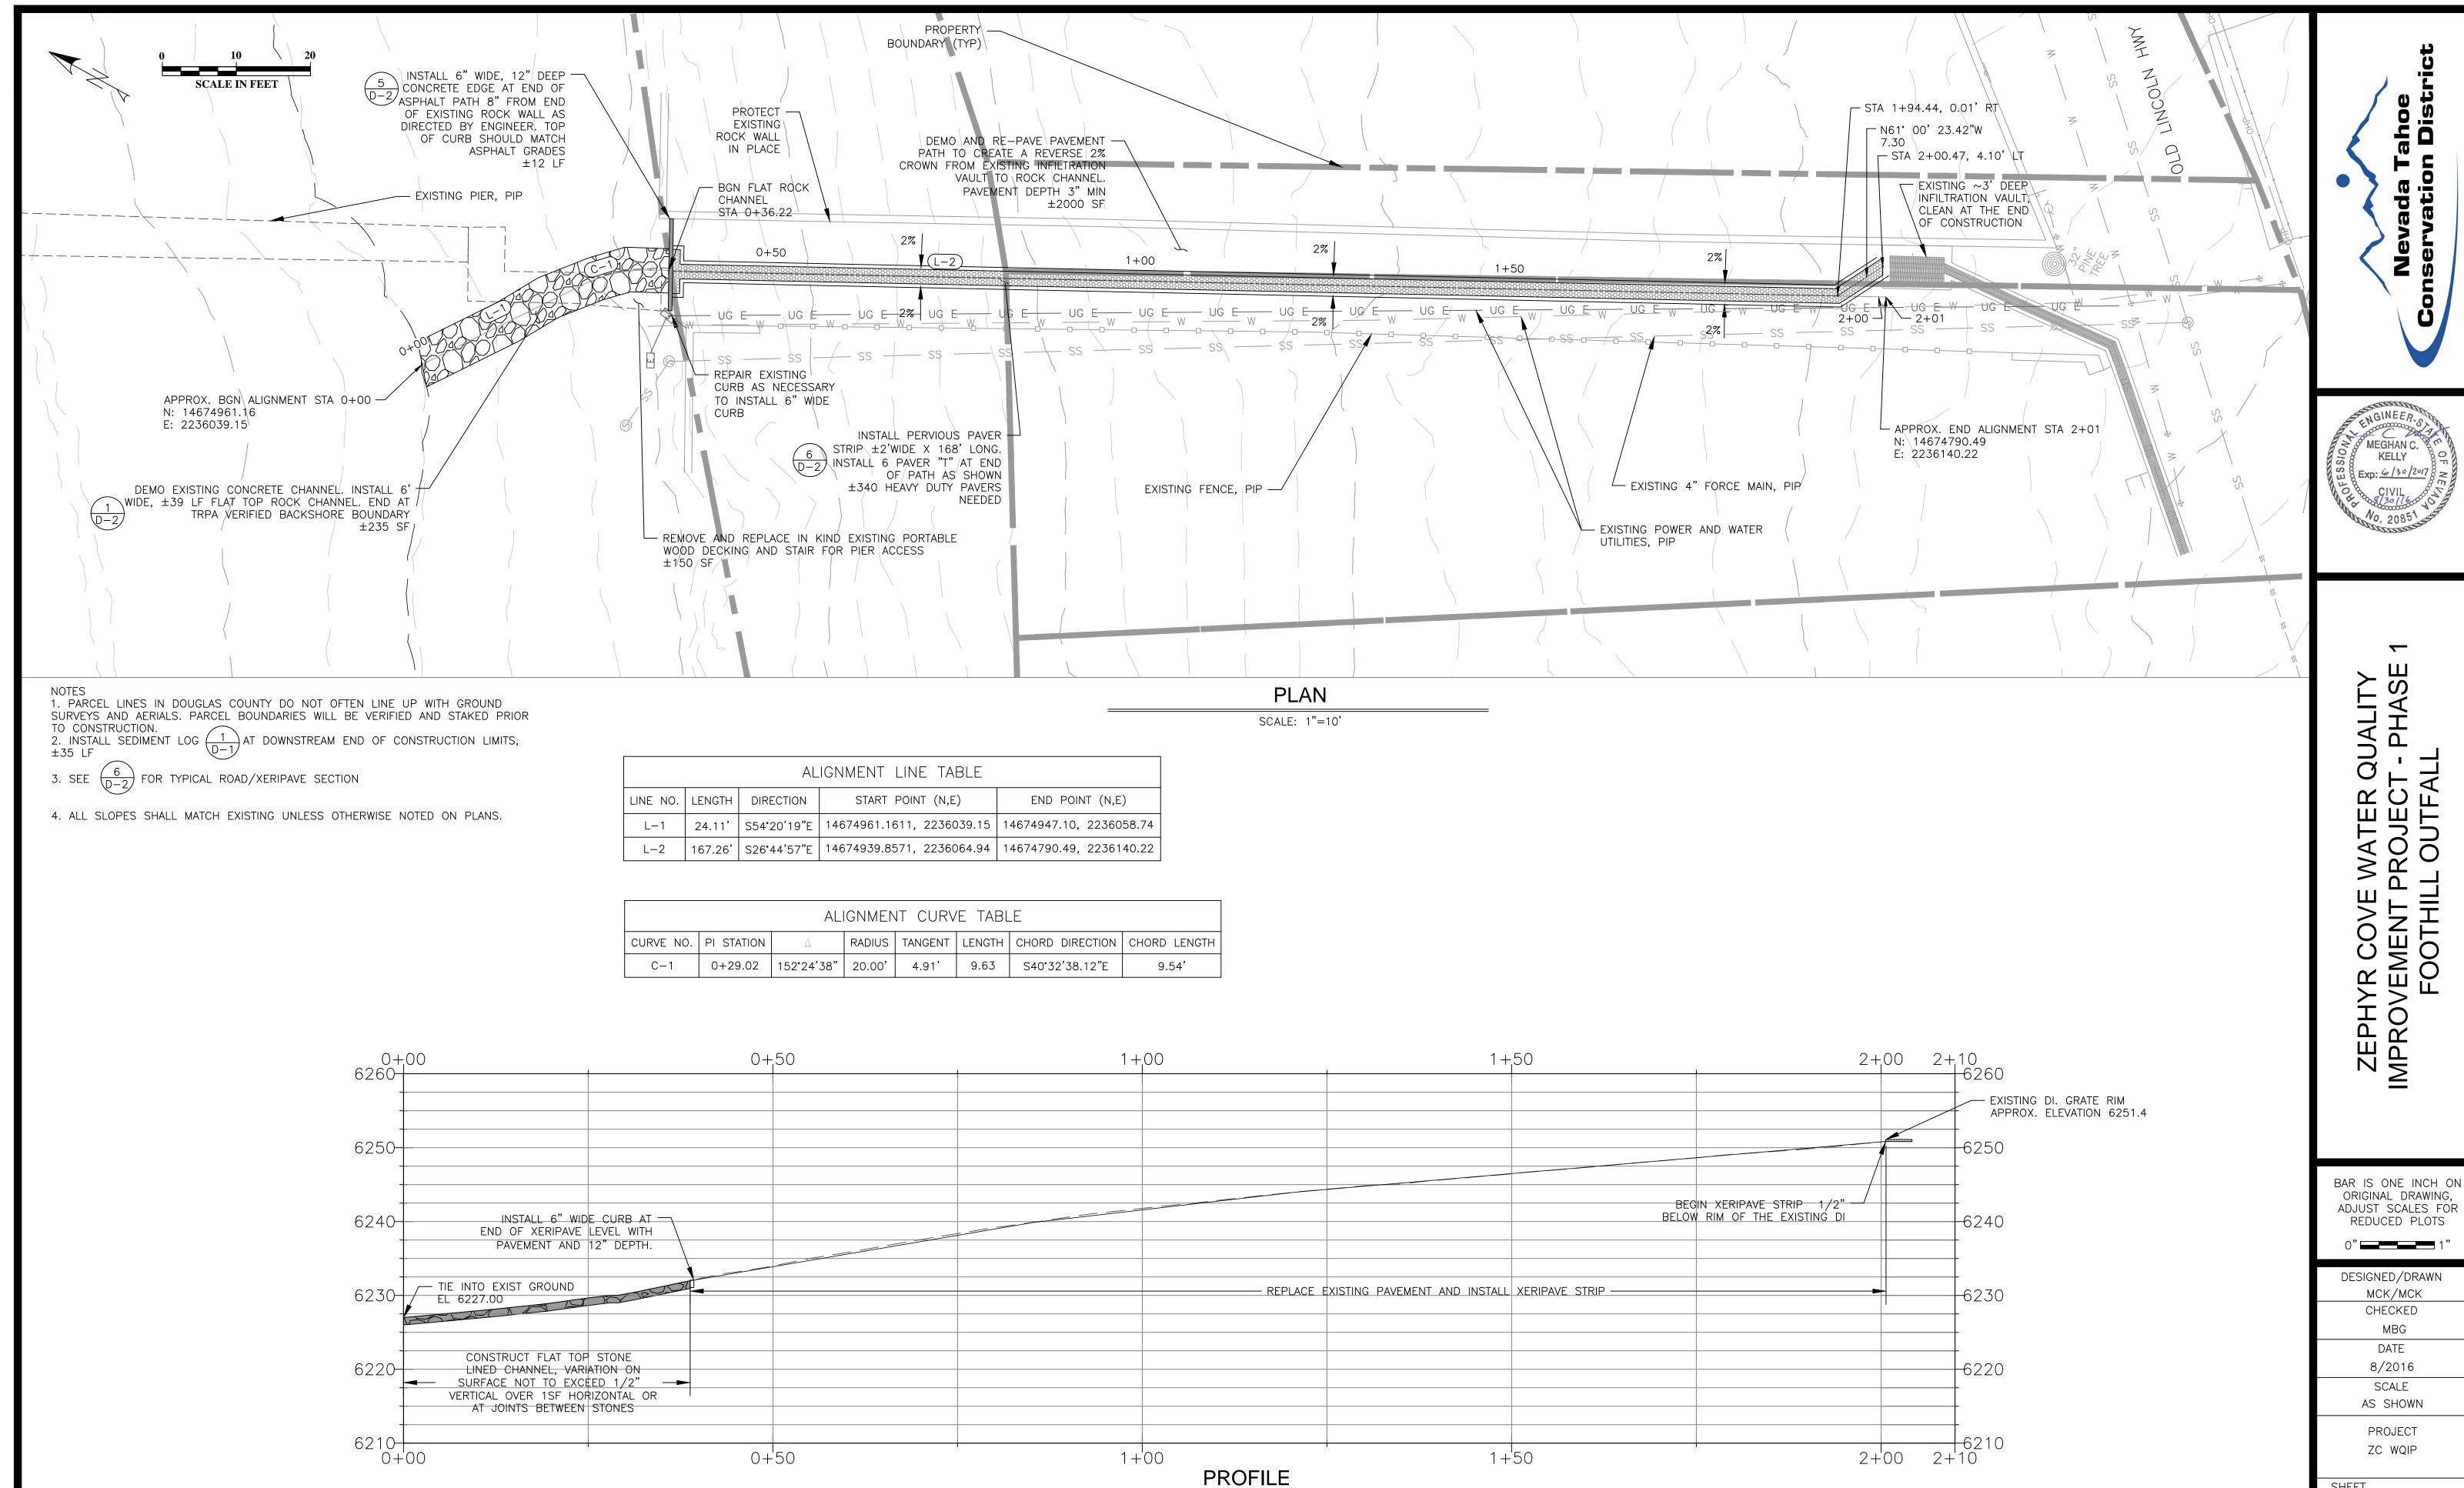

SCALE: 1"=10'

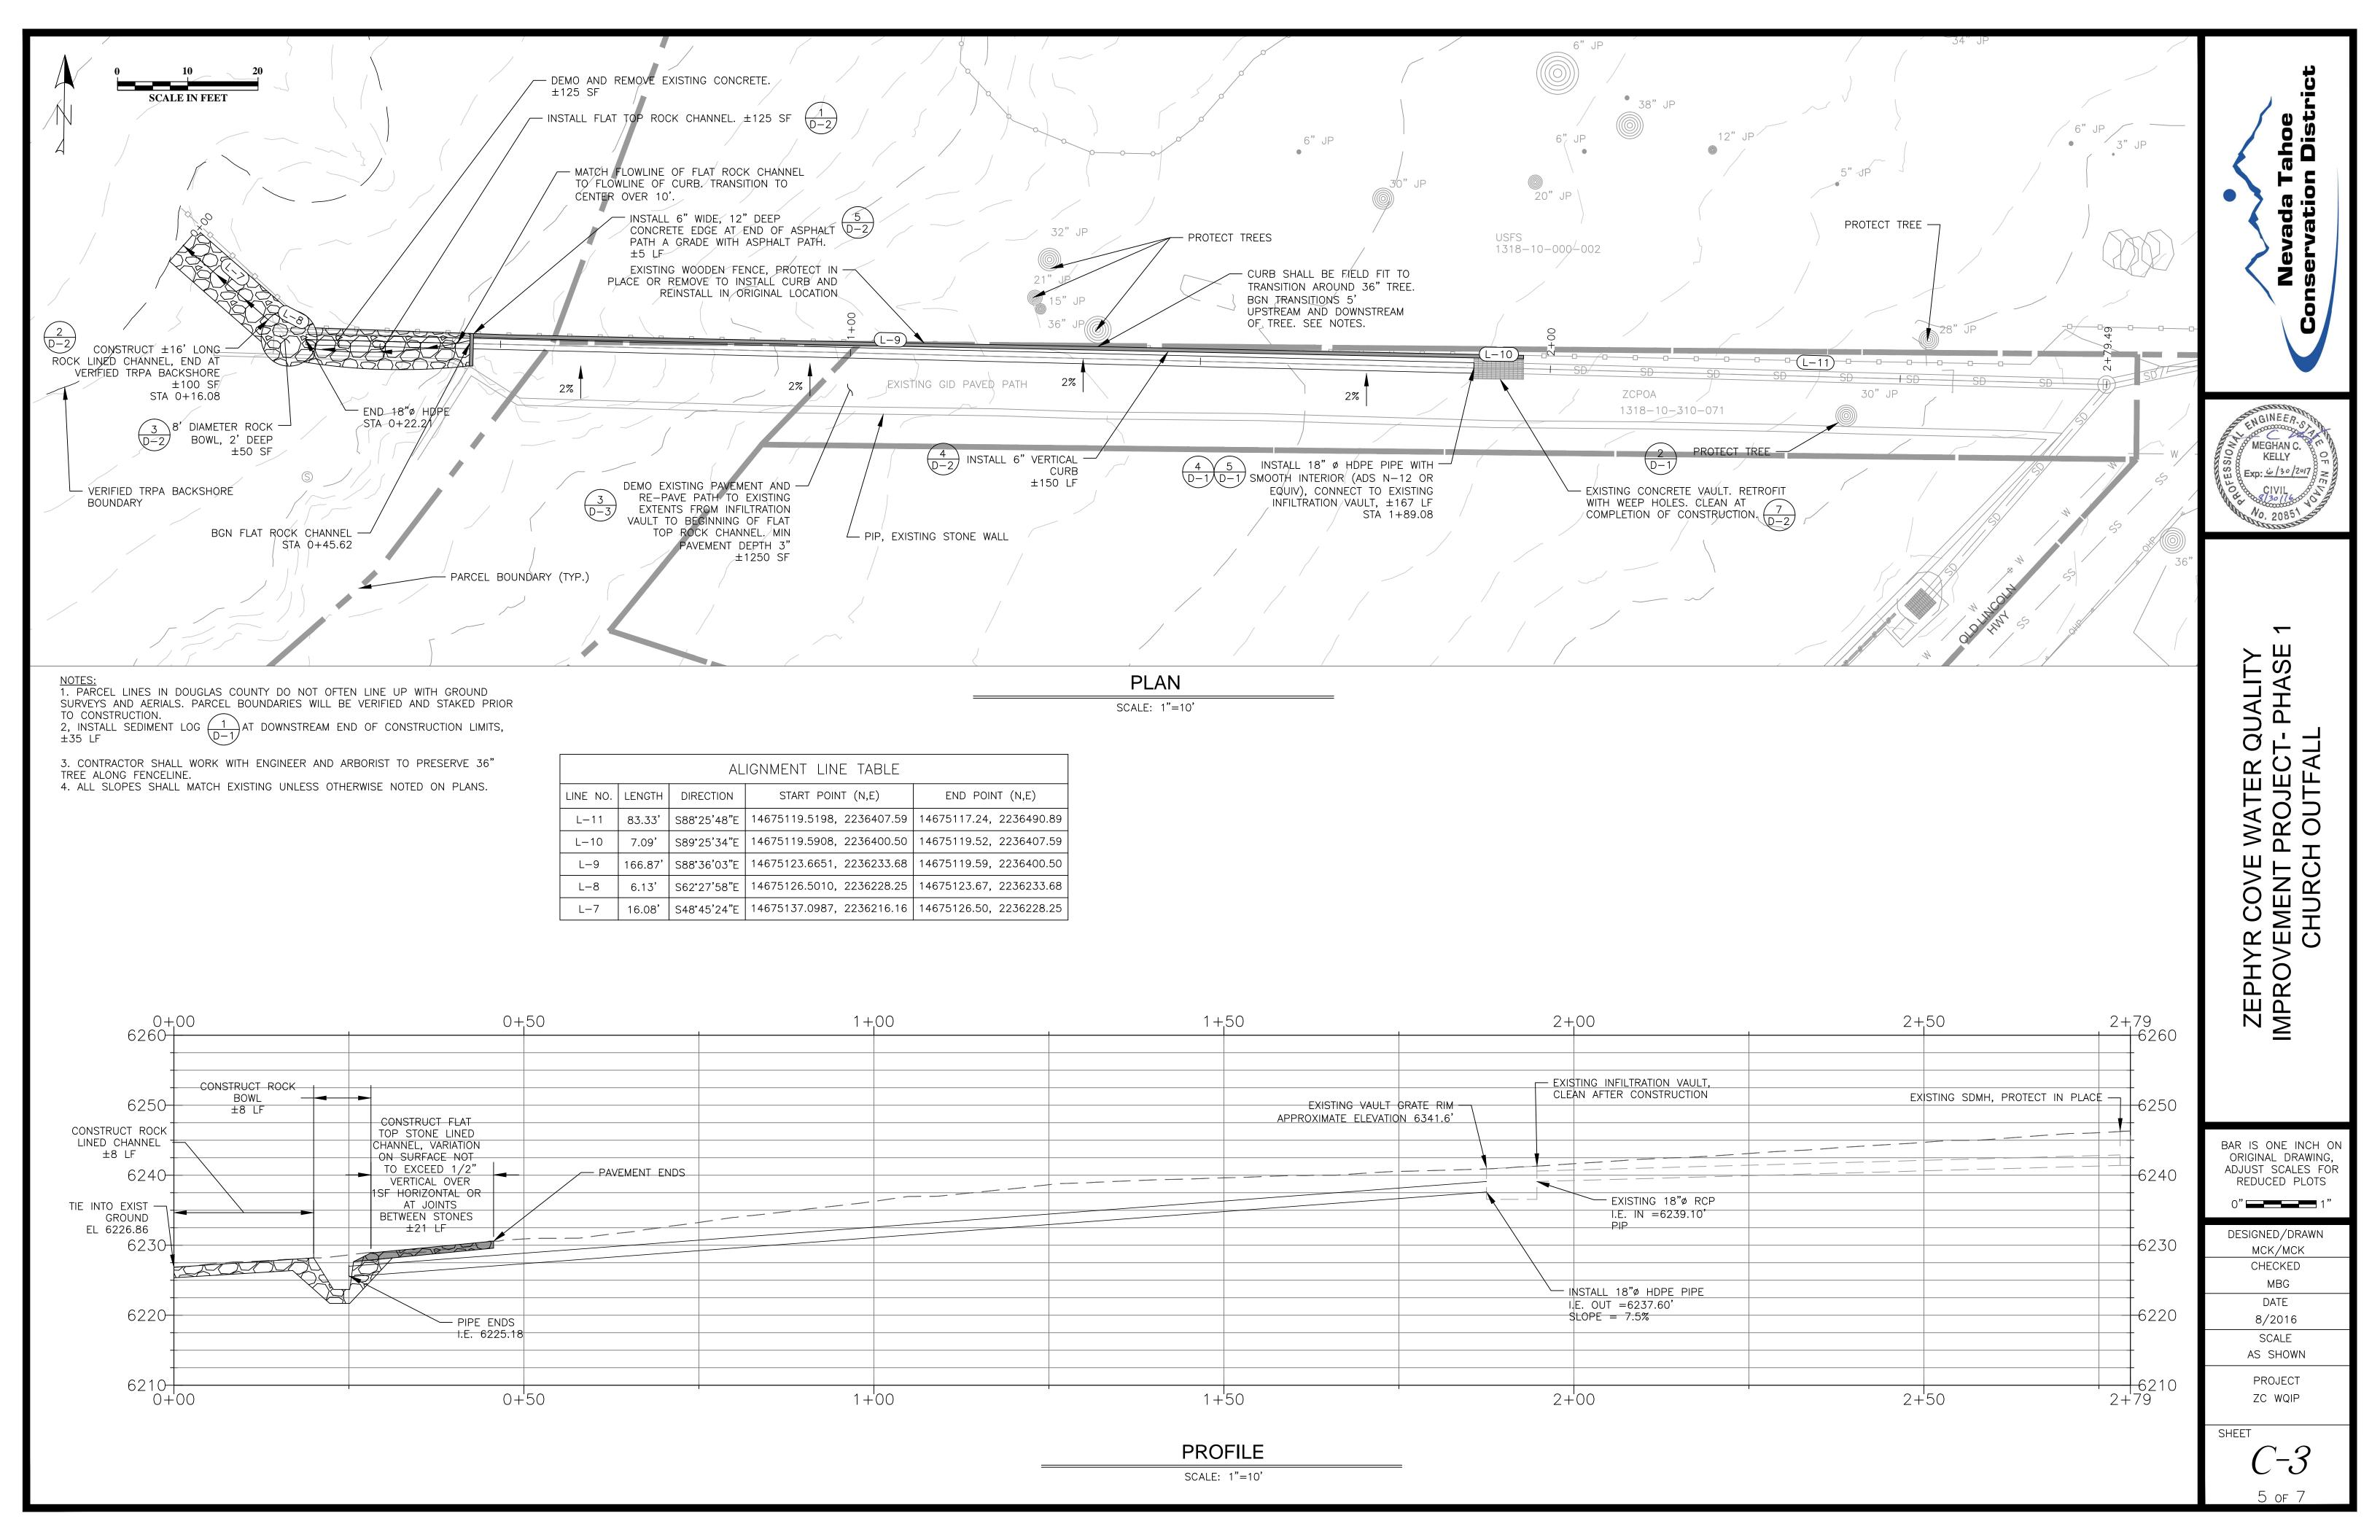

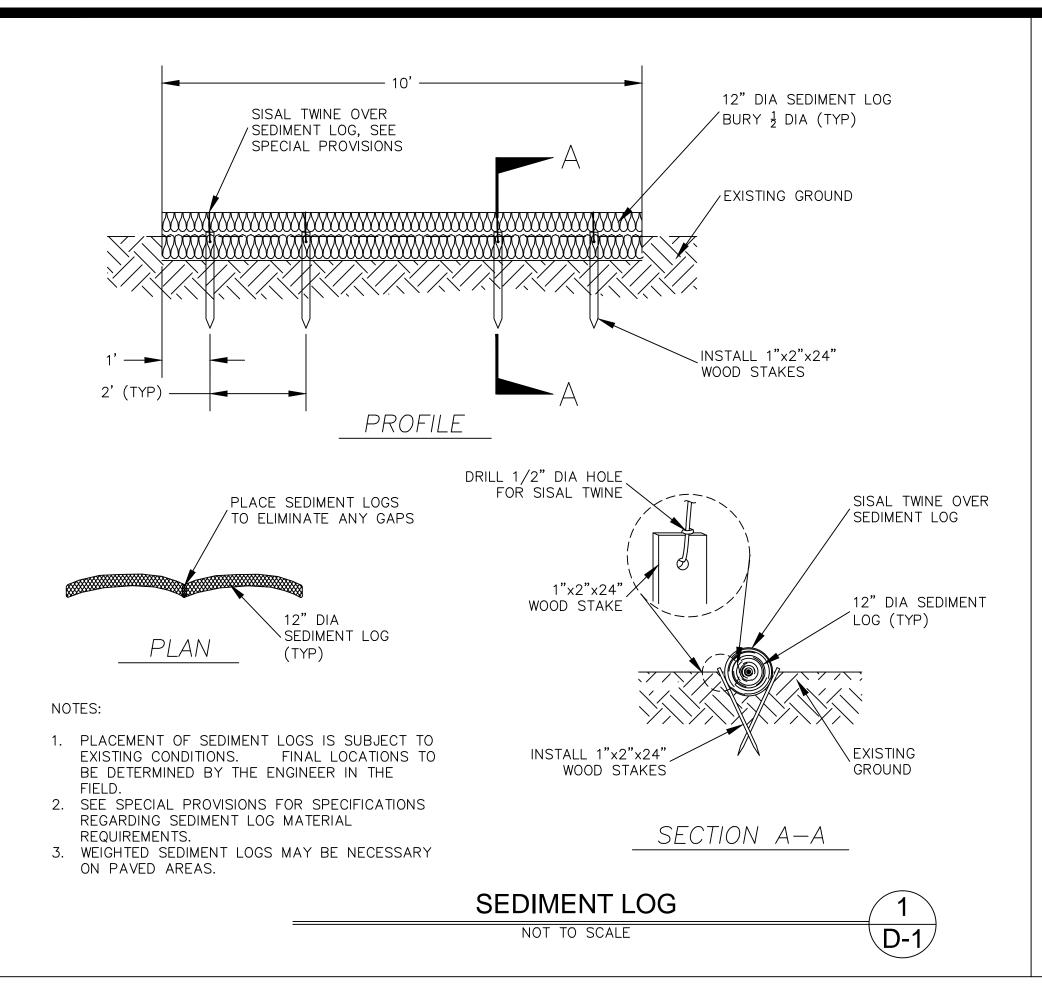

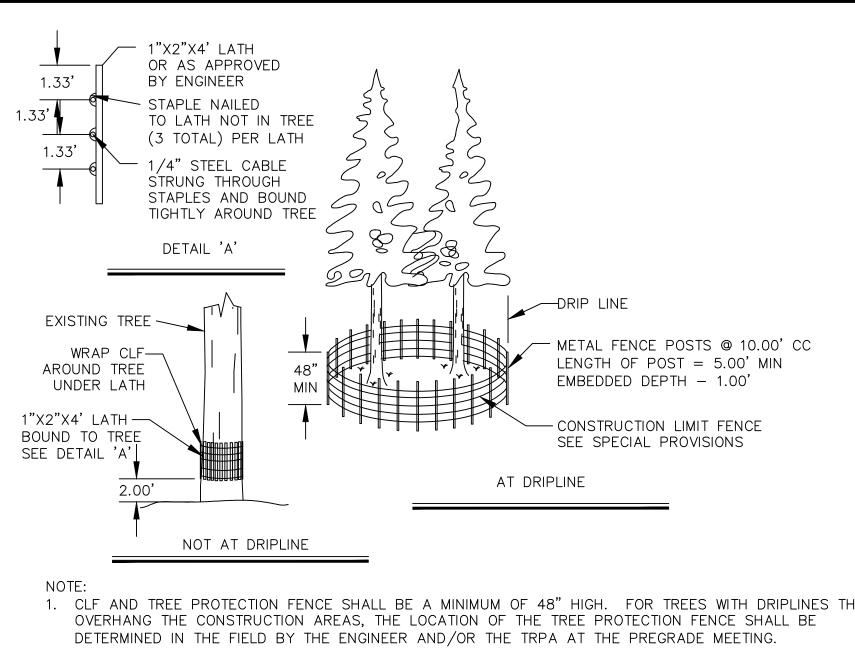


1. CLF AND TREE PROTECTION FENCE SHALL BE A MINIMUM OF 48" HIGH. FOR TREES WITH DRIPLINES THAT

2. THE DETAIL SHOWN IS FOR TREE PROTECTION. MATERIAL AND SPACING SHOWN ALSO APPLIES TO CLF. 3. QUANTITY OF FILTER FENCE AND CONSTRUCTION LIMIT FENCE DOES NOT INCLUDE MINIMUM LIMITS FOR TREE PROTECTION. TREE PROTECTION FENCING TO BE PER DETAIL THIS SHEET AND/OR AS DETERMINED IN THE FIELD.




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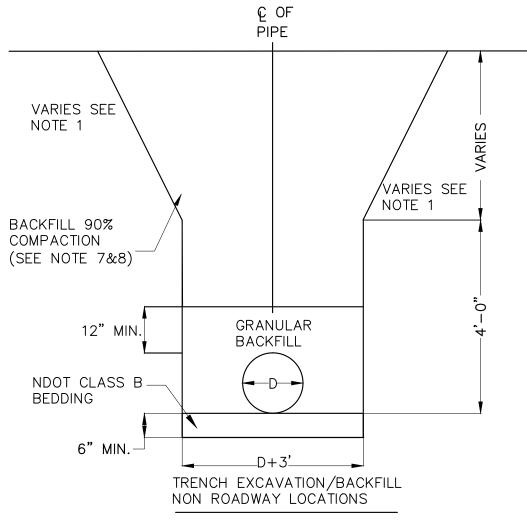


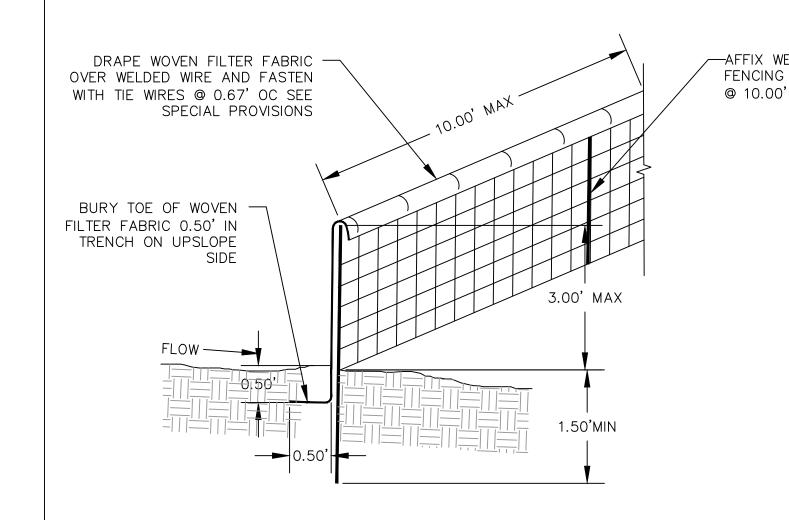NOTES: 1. CONTRACTOR MAY USE PRE MANUFACTURED SEDIMENT CONTROL FENCE AS APPROVED BY TRPA. SEE SPECIAL PROVISIONS.

> 2. PLACE FENCING SUCH THAT STORM RUNOFF CANNOT PASS AROUND OR UNDER FENCE

SEDIMENT FENCE NOT TO SCALE



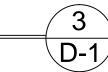



TRENCHES MORE THAN 4' DEEP SHALL BE SHORED, LAID BACK TO AT LEAST THE ANGLE OF REPOSE FOR EXISTING FIELD CONDITIONS, OR SOME OTHER MEANS OF PROTECTION SHALL BE PROVIDED.

IF HAZARDOUS FIELD CONDITIONS INDICATE GROUND MOVEMENT MAY BE EXPECTED, TRENCHES LESS THAN 4' DEEP SHALL BE PROTECTED AS INDICATED IN NOTE 1.

PAVING JOINTS IN ROADWAY ARE NOT ALLOWED IN WHEEL PATHS.

MATCH EXISTING STRIPING THROUGH LIMITS OF PATCH AREA.

A TRAVEL LANE SHALL BE MAINTAINED. TRENCH EXCAVATION INCLUDING SHIELD AND SHORING SYSTEMS SHALL COMPLY WITH CURRENT OSHA SAFETY REGULATIONS, FEDERAL REGISTER 29 CFR, PART 1926, SUBPART P.

ALL MATING SURFACES SHALL BE TACK COATED PRIOR TO PAVING (NO DIRECT PAYMENT).


SLURRY BACKFILL TRENCH TO BE USED WHEN UNABLE TO MAINTAIN A 12' TRAVEL LANE WITH THE STANDARD TRENCH OR AS DIRECTED BY THE ENGINEER.

COMPACTION SHALL BE PERCENT RELATIVE COMPACTION BASED ON THE MAXIMUM DRY DENSITY DETERMINED WITH TEST METHOD NO. NEV. T101.

METHOD NO. NEV. T101.

9. IN HIGH GROUND WATER, GRANULAR BACKFILL WRAPPED IN AN APPROVED GEOTEXTILE MAY BE USED WITH THE APPROVAL OF


10. THERE SHALL BE NO ADDITIONAL COMPENSATION FOR ANY ADDITIONAL EXCAVATION OR BACKFILL REQUIRED FOR EXCAVATIONS TO MEET OSHA REGULATIONS.

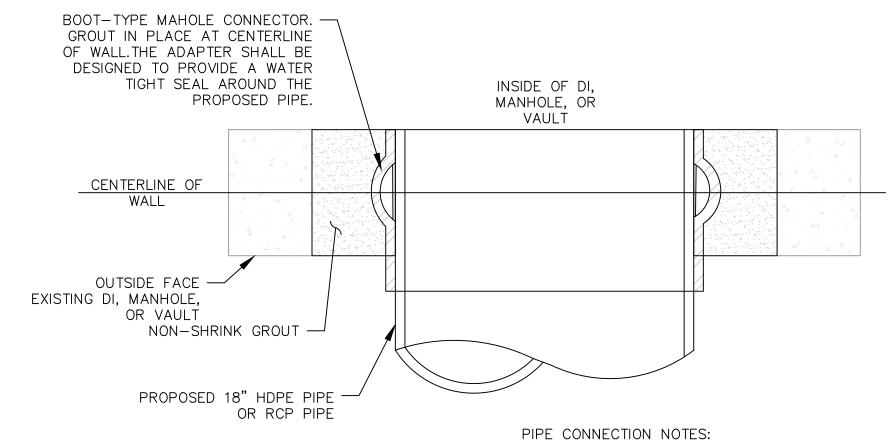

1. ALL GROUT SHOWN SHALL BE NON-SHRINK 2. CUT FLUSH WITH INSIDE OF DI, MANHOLE, OR VAULT AND BENCH INSIDE MANHOLE

NOT TO SCALE D-1/



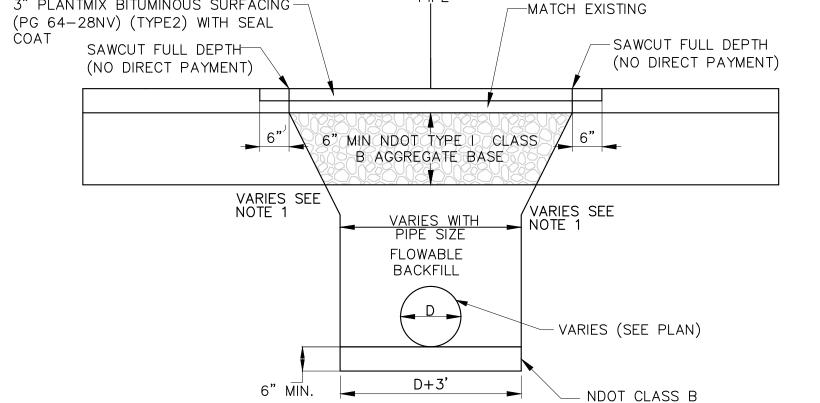

TYPICAL PATCH DETAIL

BEDDING

C OF

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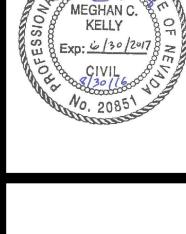
3" PLANTMIX BITUMINOUS SURFACING -

**TRENCH** NOT TO SCALE D-1 BAR IS ONE INCH ON ORIGINAL DRAWING, ADJUST SCALES FOR REDUCED PLOTS 0"

> DESIGNED/DRAWN MCK/MCK CHECKED MBG

SHEET

6 OF 7



S PHA  $\propto$ F B ZEPHYR CO IMPROVEMEN

DATE 8/2016 SCALE AS SHOWN PROJECT


ZC WQIP


INSTALL IMPROVEMENTS PER PLAN -TACK COAT ALL EXPOSED SURFACES


- 2. SURFACE TOLERANCES FOR AC PAVEMENT REPAIR SHALL CONFORM TO THE CURRENT
- 3. ASPHALT CONCRETE MATERIALS AND TESTING SHALL CONFORM THE STANDARD
- 4. AGGREGATE BASE SHALL BE TYPE 1 CLASS B COMPACTED TO 95% MDD.
- 7. PORTLAND CEMENT SHALL CONFORM TO SECTION 409 OF THE STANDARD SPECIFICATIONS
- 8. WEAKENED PLANE JOINTS SHALL BE CONSTRUCTED EVERY 5 FEET. THE JOINTS SHALL PENETRATE TO A DEPTH OF 2 INCHES AND BE CONSTRUCTED IN CONFORMANCE WITH SECTION 409.03.09 OF THE STANDARD SPECIFICATIONS.







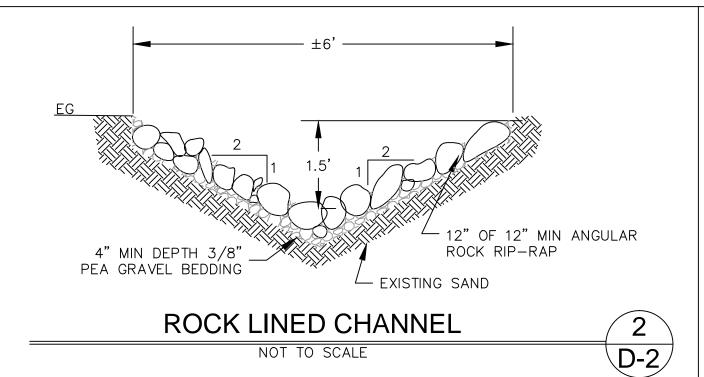

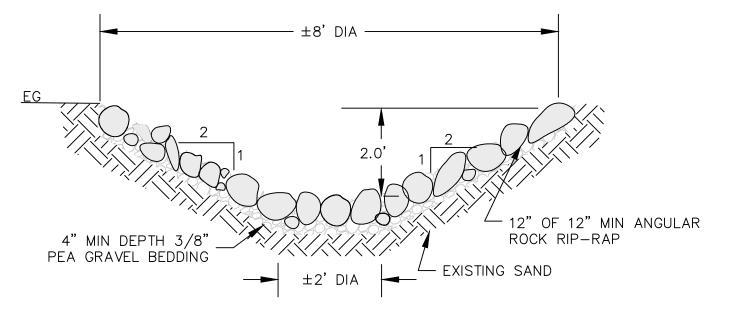

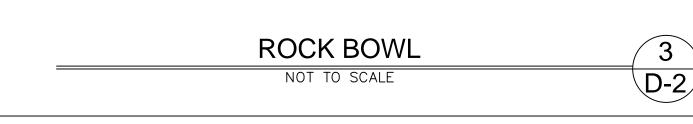


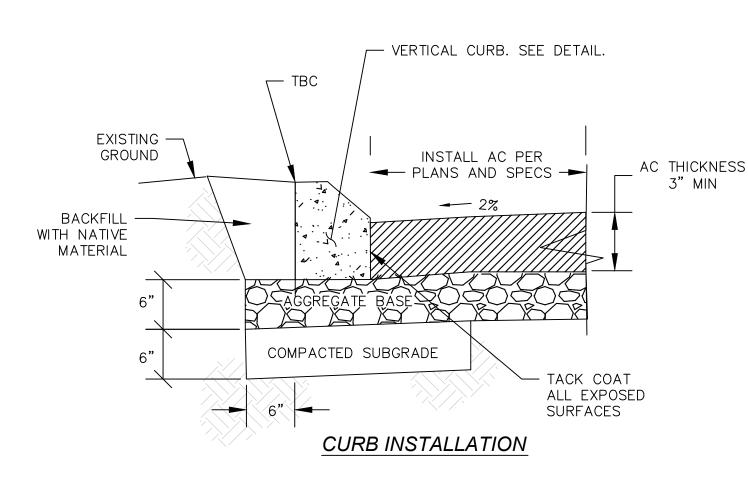

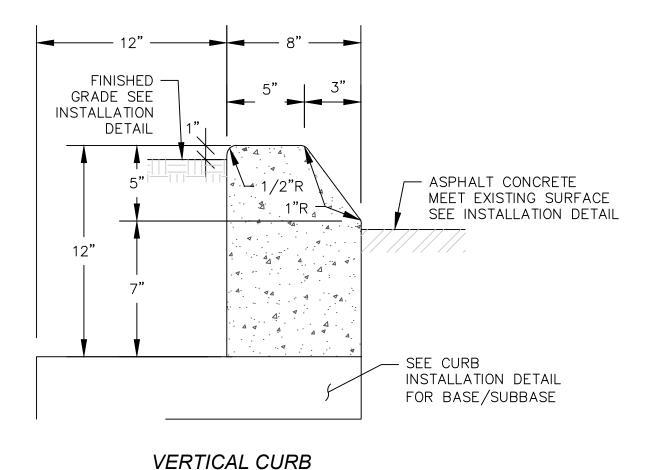


- 1. SAW CUT ALONG STRAIGHT LINES. NO SAW CUTS WITHIN WHEEL PATH
- 2. SURFACE TOLERANCES FOR AC PAVEMENT REPAIR SHALL CONFORM TO THE CURRENT EDITION OF THE STANDARD SPECIFICATIONS.
- 3. ASPHALT CONCRETE MATERIALS AND TESTING SHALL CONFORM THE STANDARD SPECIFICATIONS.
- 4. AGGREGATE BASE SHALL BE TYPE 1 CLASS B COMPACTED TO 95%
- 5. PREPARE SUBGRADE 6" MIN PER STANDARD SPECIFICATION 302.
- 6. TACKCOAT ALL EXPOSED SURFACES SS-1h, 0.07-0.13 GAL/SY 7. PORTLAND CEMENT SHALL CONFORM TO SECTION 409 OF THE STANDARD SPECIFICATIONS FOR CONCRETE EXPOSED TO
- FREEZE-THAW ENVIRONMENTS. 8. WEAKENED PLANE JOINTS SHALL BE CONSTRUCTED EVERY 5 FEET. THE JOINTS SHALL PENETRATE TO A DEPTH OF 2 INCHES AND BE CONSTRUCTED IN CONFORMANCE WITH SECTION 409.03.09 OF THE STANDARD SPECIFICATIONS.




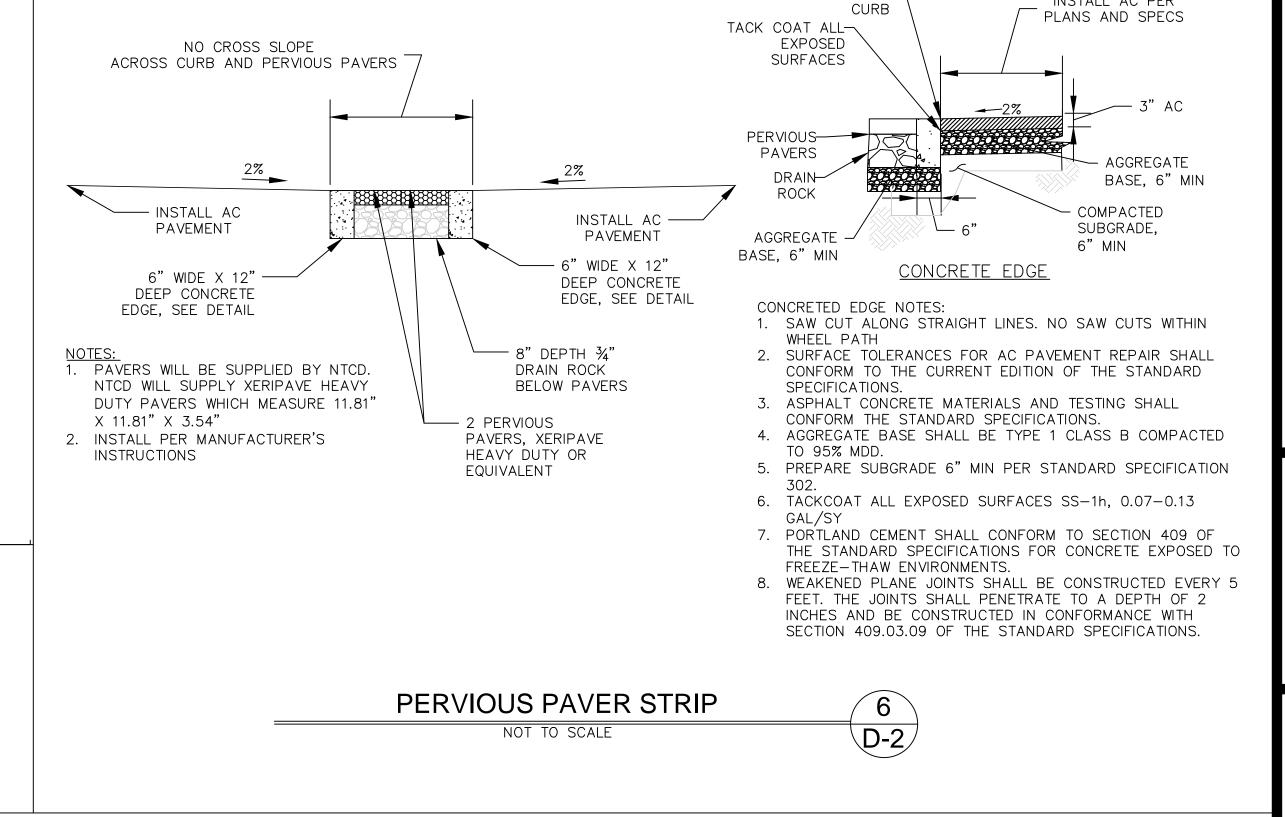

VERTICAL

INSTALL AC PER

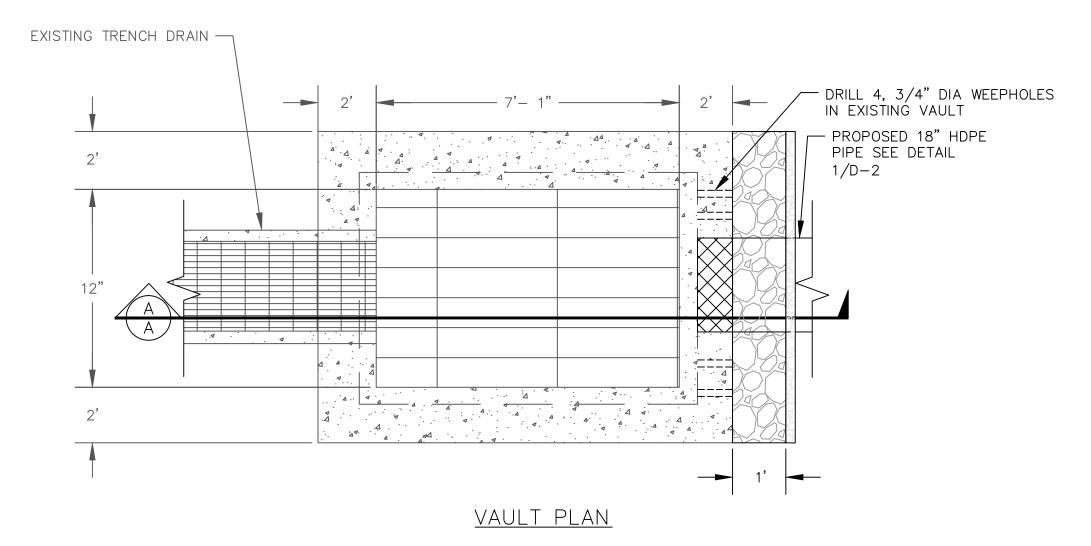

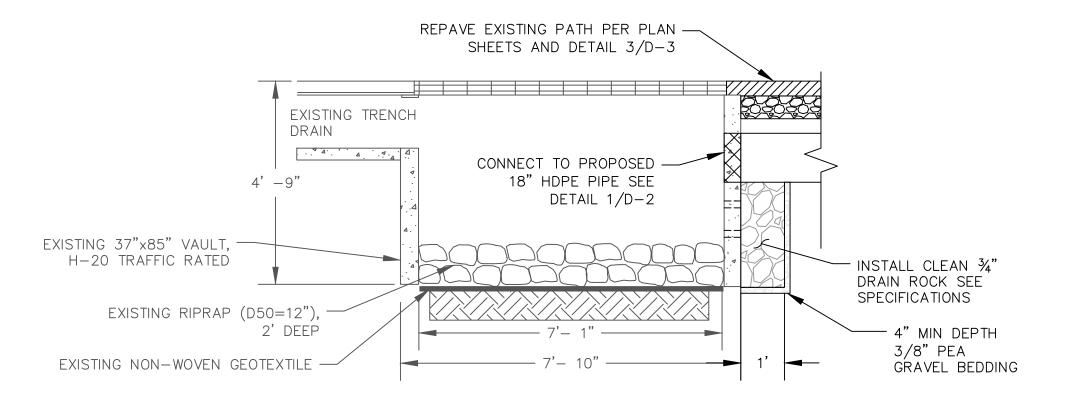

SECTION A-A

RETROFIT INFILTRATION VAULT WITH WEEP HOLES NOT TO SCALE \D-2



Ü

PHA Q  $\mathbf{\alpha}$ F B ZEPHYR CO IMPROVEMEN

BAR IS ONE INCH ON ORIGINAL DRAWING, ADJUST SCALES FOR REDUCED PLOTS

0"

DESIGNED/DRAWN MCK/MCK CHECKED

> MBG DATE 8/2016

SCALE AS SHOWN

PROJECT ZC WQIP

SHEET

7 of 7